




**RESERVIOR SIDE ELEVATION**  
**SCALE 1:50**

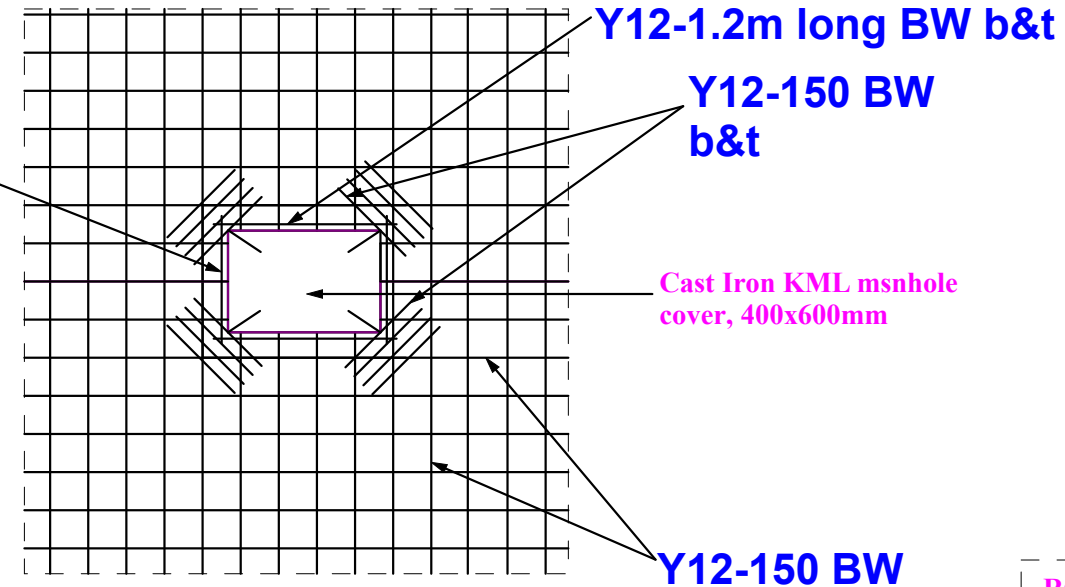


**DETAIL-03**  
**SCALE 1:25**

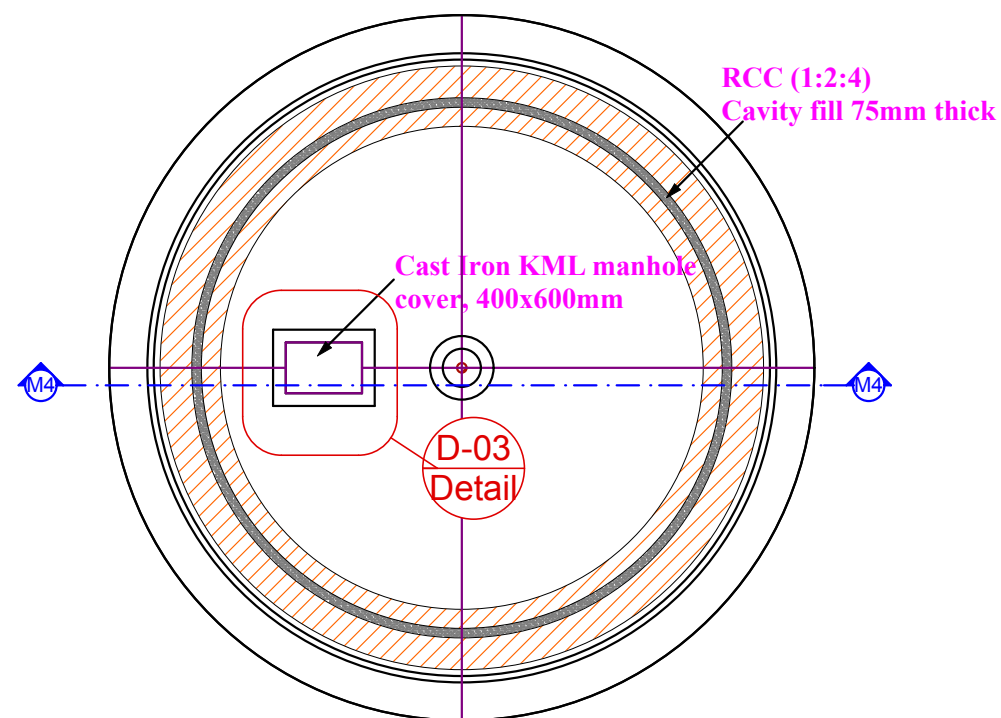

**RESERVIOR FLOOR PLAN**  
**SCALE 1:50**

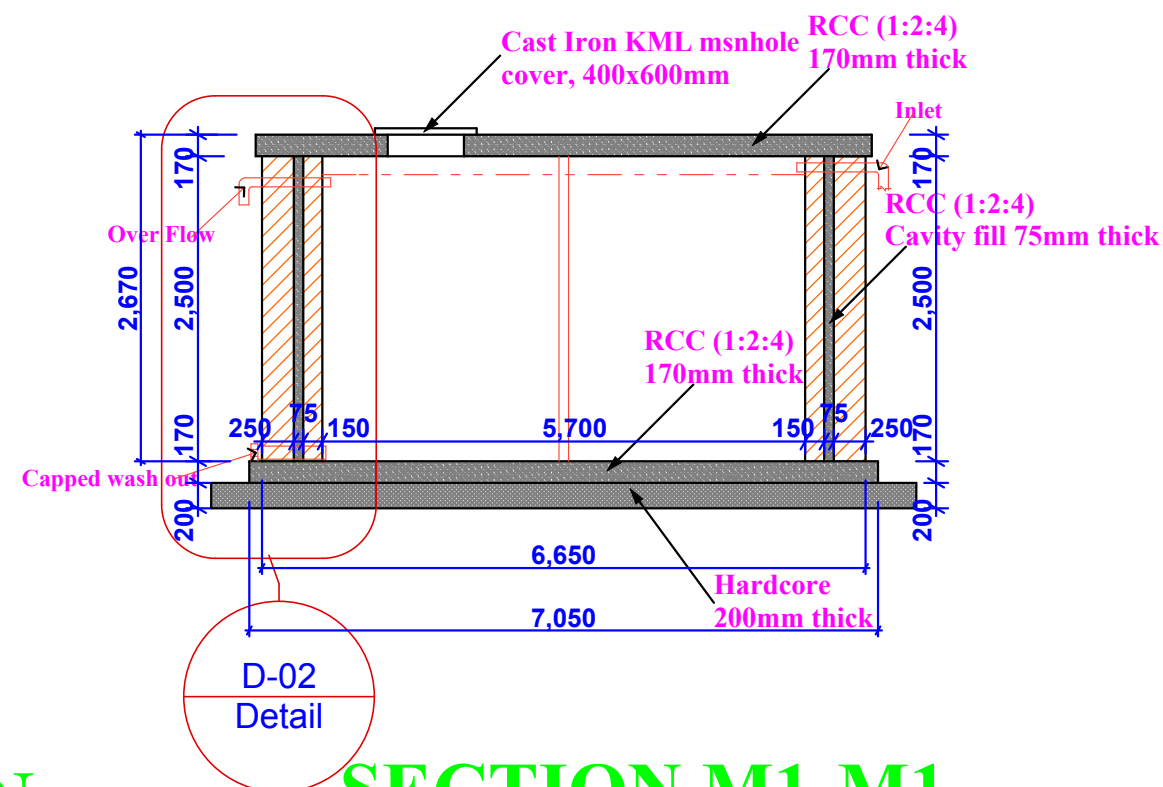

**SECTION M1-M1**  
**SCALE 1:50**

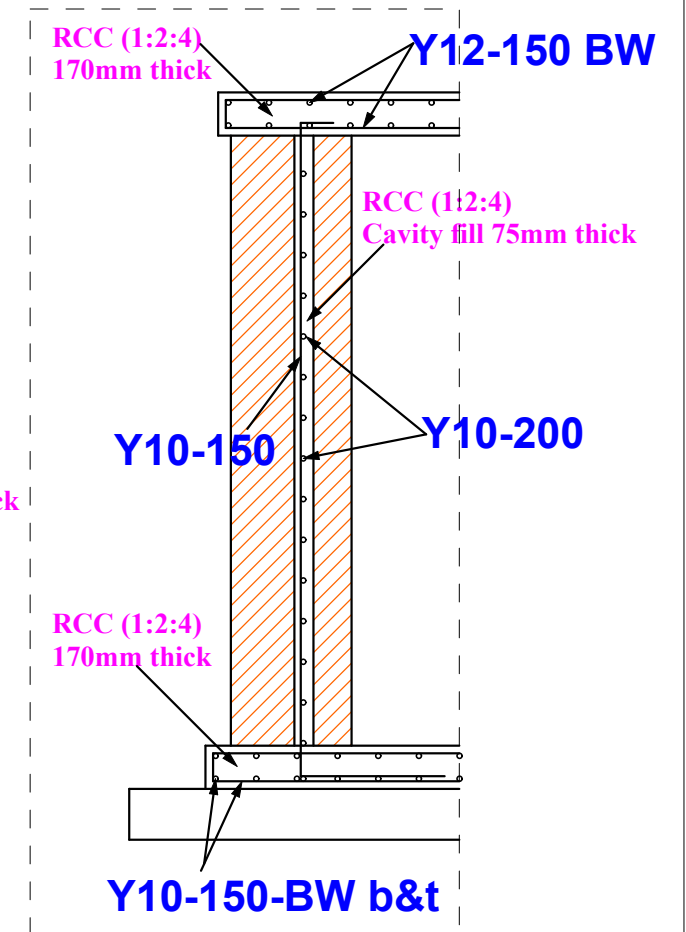

**DETAIL-02**  
**SCALE 1:25**



**PROPOSED WATER  
EXTENSION FROM  
RWENTUHA TO  
BENEFICIARY AREAS**

**NOTES / DESCRIPTION**

- 1). All dimensions in millimetres unless otherwise stated
- 2). All structural concrete in 1:2:4 mix
- 3). All stone masonry works in 1:3 cement sand mortar
- 4). All lean concrete in 1:4:8 mix

**RESERVOIR TANK 60CM**

**STRUCTURAL DETAILS**

*Drawing No. RWNT/Str/01*

*Drawn by: Wash Engineer*

*Scale:*

*Hor: AS SHOWN Vert: AS SHOWN Date: August. 2023*